



WARNING

BEWARE OF EXISTING UNDERGROUND SERVICES.

ONTRACTOR SHALL CONFIRM LOCATIONS OF SERVICES

PRIOR TO EXCAVATION. COORDINATE WITH

ALL RELEVANT AUTHORITIES.

GIFTED ASSETS



SITE PLAN (1:1000 AT A1)

NOTES

- 1 REFER DWG No. B20-15007 FOR DETAILS OF ITEMS LISTED IN LEGEND.
- 2 CONTRACTOR SHALL LOCATE EXISTING EARTH CABLING IN LOCATIONS SHOWN, JOINT NEW 1x1C 70 Sq mm Cu, BARE EARTH CABLING & EXTEND TO AND CONNECT TO NEW DIST PILL AR P4167U
- 3 CONTRACTOR SHALL LOCATE EXISTING SAND PITS AT LOCATIONS SHOWN & INSTALL NEW DIST. CABLING WITHIN EXISTING SPARE 1x100mm HD uPVC CONDUIT & THEN DIRECT BURIED TO NEW DIST. PILLAR P416ZU.
- 4 CONTRACTOR SHALL LEAVE SUFFICIENT LENGTHS NEW LV DIST. CABLING (FROM NEW DIST. PILLAR P416ZU) COILED WITHIN EXISTING SAND PIT IN FRONT OF EXISTING DIST. PILLAR P080ZU & ARRANGE FOR POWER AND WATER TO PULL NEW LV DIST. CABLING THROUGH EXISTING SPARE 1x100mm SWEEP BEND INTO EXISTING DIST. PILLAR P080ZU & CONNECT / TEDMINATE
- 5 LV CABLING SHALL BE RUN BELOW (DEEPER THAN STANDARD ELECTRICAL TRENCH DEPTH/COVER) SEWER/DRAINAGE WITH A MINIMUM OF 300mm CLEARANCE AT CROSSOVER LOCATIONS, COORDINATE ON SITE WITH CIVIL CONTRACTOR.
- 6 MINIMUM 300mm HORIZONTAL SEPARATION REQUIRED BETWEEN EDGE OF NBN CONDUIT/S & LV CABLING. TRENCH WIDTH MAYBE EXTENDED BY 200mm TOWARDS PROPERTY BOUNDARY TO ENSURE 300mm HORIZONTAL SEPARATION PROVIDED. WHERE 300mm SEPARATION NOT PROVIDED, LV CABLING SHALL BE INSTALLED IN 100mm HD upvc conduit. ALSO REFER DWG No. B20-15003, DETAILS B & C.

PILLAR SCHEDULE									
PILLAR	630A STRIPPLE FUSE UNIT	160A STRIPPLE FUSE UNIT							
P390ZU	3	1							
P391ZU	2	1							
P392ZU	2	1							
P401ZU	1	1							
P402ZU	2	1							
P403ZU	2	1							
P404ZU	2	1							
P405ZU	2	1							
P406ZU	2	1							
P407ZU	3	1							
P408ZU	2	1							
P409ZU	3	1							
P410ZU	2	1							
P416ZU	3	1							

LEGEND

- NEW PACKAGE SUBSTATION (RATING AS SHOWN).
 'E' INDICATES EXISTING.
- MEW DISTRIBUTION DOUBLE LINK PILLAR FUSED TYPE. 'E' INDICATES EXISTING/'F' INDICATES FUTURE.
- NEW DISTRIBUTION LINK PILLAR FUSED TYPE.
 'E' INDICATES EXISTING/'F' INDICATES FUTURE.
- NEW DISTRIBUTION PILLAR FUSED TYPE. 'F' INDICATES FUTURE.
- RODP RODD NEW ROAD OWNER DIST. PILLAR (AS PART OF STREET LIGHTING WORKS).
- . E . EXISTING LV DISTRIBUTION CABLE 0.6/1kV 4 x 1C 240 Sq mm AI, XLPE/NJ/PVC DIRECT BURIED (OR WITHIN CONDUIT AT ROAD CROSSING) & 1x1C 70 Sq mm Cu, BARE EARTH DIRECT BURIED.
- NEW LV DISTRIBUTION CABLE 0.6/1kV 4 x 1C 240 Sq mm Al, XLPE/NJ/PVC DIRECT BURIED (OR WITHIN CONDUIT AT ROAD CROSSING) & 1x1C 70 Sq mm Cu, BARE EARTH DIRECT BURIED. ALSO REFER NOTE 6.
- · · F · · FUTURE LV DISTRIBUTION CABLE 0.6/1kV 4 x 1C 240 Sq mm AI, XLPE/NJ/PVC DIRECT BURIED (OR WITHIN CONDUIT AT ROAD CROSSING) & 1x1C 70 Sq mm Cu, BARE EARTH DIRECT BURIED.
- $--\frac{E}{}$ EXISTING LV SERVICE CABLE 0.6/1kV 2 x 1C 25 Sq mm Cu, XLPE/NJ/PVC DIRECT BURIED (OR WITHIN CONDUIT AT ROAD CROSSING).
- --^{LV} -- NEW 3 PHASE LV SERVICE CABLE (SUPPLY TO ROAD OWNER DIST. PILLAR) 0.6/1kV 4x1C 25 Sq mm Cu, XLPE/NJ/PVC ENCLOSED IN 80mm HD uPVC CONDUIT.
- $-\frac{3\phi(F)}{2}$ FUTURE 3 PHASE CONSUMER MAINS BY LOT OWNER.


DEVELOPER:											DRAWING STATUS	APPD	DATE
TERRITORY LIFE	AGA CONSU									Р	PRELIMINARY/PROPOSED		
GPO Box 1779		L & MECHANICAL								Т	TENDERING PURPOSES ONLY		
DARWIN NT 0801	ACN 070 242 296							B20_15008	CINCLE LINE DIAGDAM & LEGEND	AC	APP. FOR CONSTRUCTION		
								B20-15008 B20-15007 B20-15006 B20-15005 B20-15003	SINGLE LINE DIAGRAM & LEGEND NOTES, ASSET SCHEDULES & HV SCHEMATICS MASTER SERVICES PI IN	Al	AS INSTALLED		
PHONE: 0417 160700	GPO BOX 3097	TELEPHONE: 08 89416582	0	CONTRACT DRAWING	K.T.	9-10-20	A.G.	B20-15005 B20-15003	MASTÉR SERVICES PLAN CONDUIT/DUCT LAYOUT HY ELECTRICAL RETICULATION	С	CANCELLED/SUPERSEDED		
FACSIMILE: EMAIL: clement.williams@territorylife.com.au	DARWIN NT 0801	FACSIMILE: 08 89421400	NO	DESCRIPTION	DRN	DATE	APPD	DRG NO	TITLE				
CONTACT: CLEMENT WILLIAMS		EMAIL: alekg@agaeng.com.au		AMENDMENTS					ASSOCIATED DRAWINGS		AGA406-20A		



DES	A.GANGUR	POWER	SERVICES -	PALMERSTON	DISTRIBUTION	١
DRN	K.TAVENER	SUBDIV	ISION OF LOT	12087		
CKD	A.GANGUR	ZUCCOI	LI SUBDIVISION	- STAGE 2	: STAGE 211	
APPD		LV ELE	CTRICAL RETIC	JLATION		
SCALE	1:1000 AT A1					
ISSUED	9-10-20	Λ 1	DRAWING	B20-15	NO.	\wedge
ALL DIM	I IN mm	AI	NUMBER	DZU- IC)UU4	/0\

TAMDT

DRAFTING STANDARD TO A.S.1100 FILE No: NE590/12087

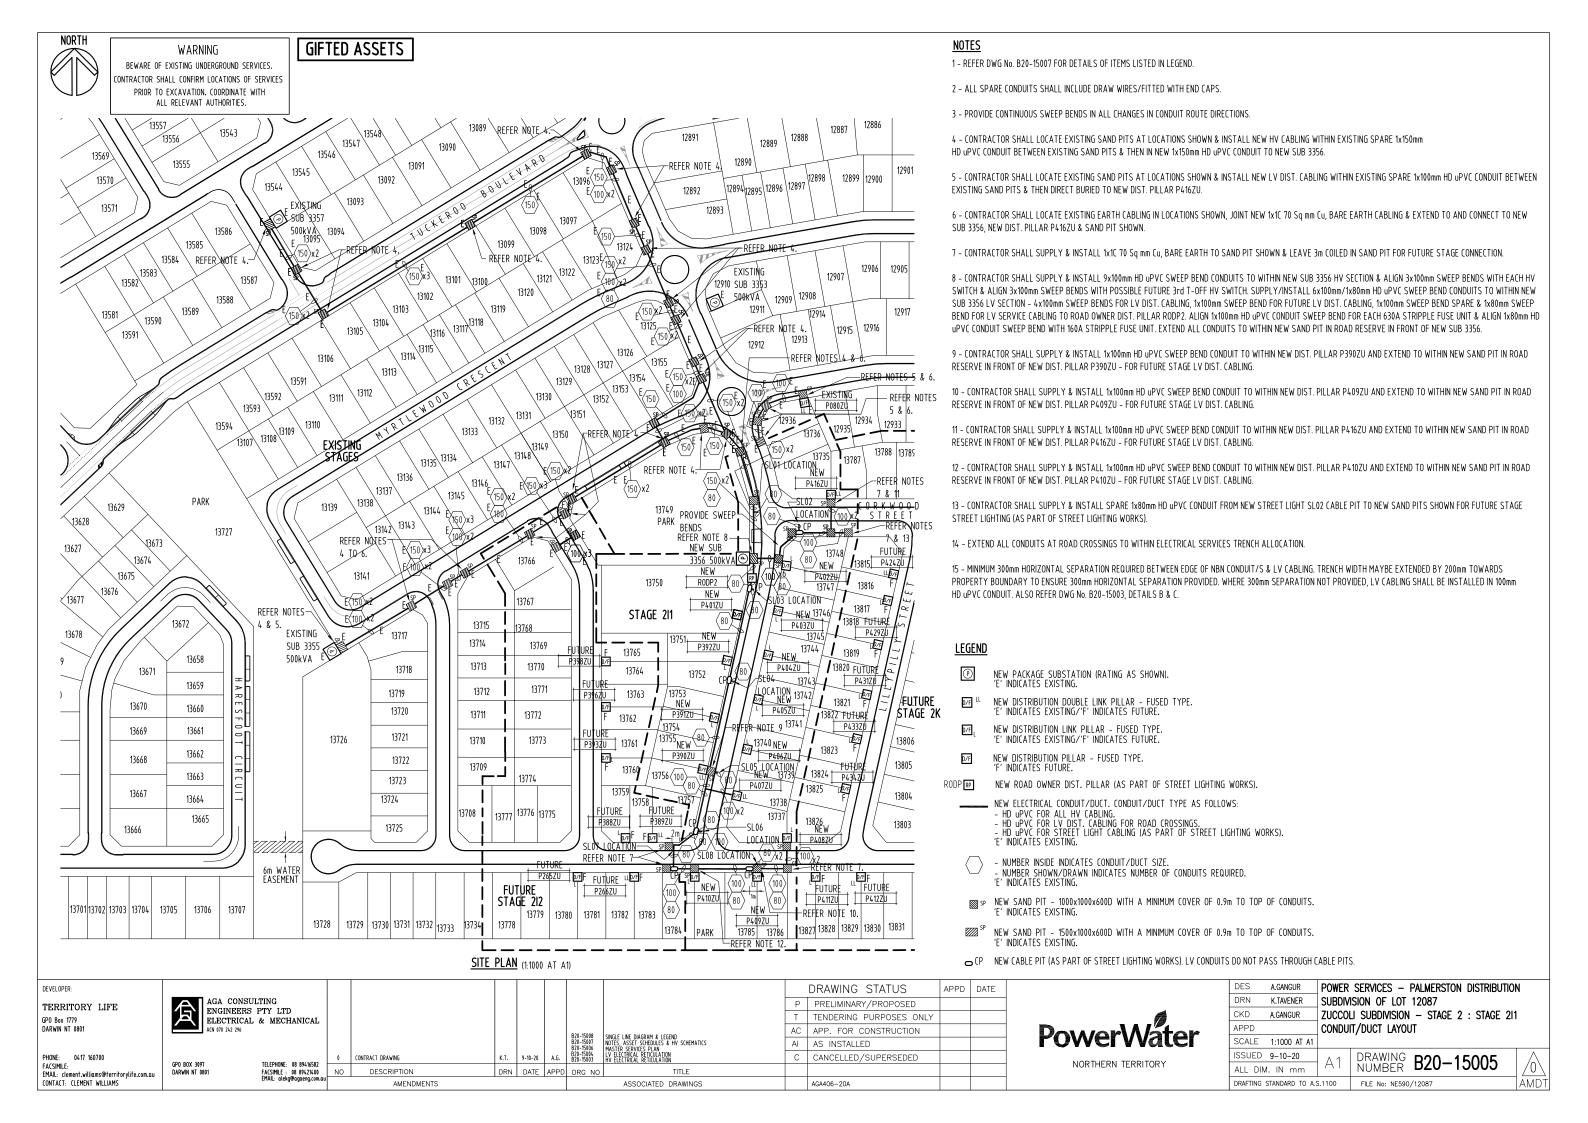

NORTH

WARNING

BEWARE OF EXISTING UNDERGROUND SERVICES. ONTRACTOR SHALL CONFIRM LOCATIONS OF SERVICES PRIOR TO EXCAVATION, COORDINATE WITH ALL RELEVANT AUTHORITIES.

13584

13589

、13583[\]

13590

13582

13591

13581

13629

****3673

13672

13658

13659

13660

13661

13662

13663

13664

13665

13706

13707

13674

13671

13670

13669

13667

13666

13701 13702 13703 13704 13705

13675

13676

\13628

13627

13677

13678

GIFTED ASSETS

13587

13588

13594

13727

PARK

NOTES

12906

12916 \12915 \

12934 \ <u>12933</u>

13788 | 13789

/13808

13807

13806

13803

13827 13828 | 13829 | 13830 | 13831

13805 STAGE 2K

12905

12917

1 - REFER DWG No. B20-15007 FOR DETAILS OF ITEMS LISTED IN LEGEND (EXCLUDING WATER/SEWER/DRAINAGE CONNECTION).

LEGEND

(3)

0

NEW PACKAGE SUBSTATION (RATING AS SHOWN). 'F' INDICATES EXISTING.

NEW DISTRIBUTION DOUBLE LINK PILLAR - FUSED TYPE. D/F ^L 'INDICATES EXISTING/'F' INDICATES FUTURE.

NEW DISTRIBUTION LINK PILLAR - FUSED TYPE. 'E' INDICATES EXISTING/'F' INDICATES FUTURE.

NEW DISTRIBUTION PILLAR - FUSED TYPE. D/F

RODP RP NEW ROAD OWNER DIST. PILLAR (AS PART OF STREET LIGHTING WORKS).

-_E___ EXISTING LV SERVICE CABLE/CONNECTION.


 $--\frac{3\phi(F)}{2}$ FUTURE 3 PHASE CONSUMER MAINS - BY LOT OWNER.

W NEW WATER CONNECTION. ' INDICATES EXISTING


> NEW SEWER CONNECTION. 'E' INDICATES EXISTING.

NEW DRAINAGE CONNECTION.

'E' INDICATES EXISTING.

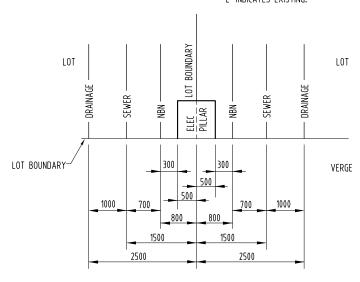

DETAIL D - TYPICAL OFFSETS FOR ELEC/NBN/SEWER/DRAINAGE/WATER LOT CONNECTIONS - ELEC PILLAR IN 2 LOTS (N.T.S.)

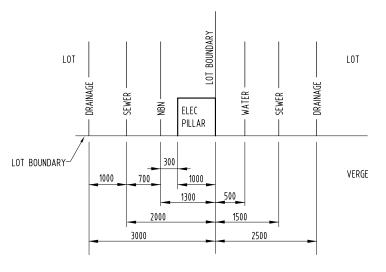

DETAIL E - TYPICAL OFFSETS FOR ELEC/NBN/SEWER/DRAINAGE/WATER LOT CONNECTIONS - ELEC PILLAR IN 1 LOT (N.T.S.)

TERRITORY LIFE GPO Box 1779 DARWIN NT 0801

PHONE: 0417 160700 FACSIMLE: EMAIL: clement.williams@territorylife.com.au CONTACT: CLEMENT WILLIAMS

AGA CONSULTING ENGINEERS PTY LTD ELECTRICAL & MECHANICAL GPO BOX 3097 DARWIN NT 0801 TELEPHONE: 08 89416582

CONTRACT DRAWING 9-10-20 NO DESCRIPTION FACSIMILE: 08 89421400 EMAIL: alekg@agaeng.com.

DRAWING STATUS APPD DATE PRELIMINARY/PROPOSED T TENDERING PURPOSES ONLY AC APP. FOR CONSTRUCTION SINGLE LINE DIAGRAM & LEGEND NOTES, ASSET SCHEDULES & HV SCHEMATICS CONDUIT/DUCT LAYOUT LV ELECTRICAL RETUCULATION HV ELECTRICAL RETUCULATION AI AS INSTALLED C CANCELLED/SUPERSEDED DRN DATE APPD DRG NO AMENDMENTS ASSOCIATED DRAWINGS AGA406-20A

13124

13126

、13153[\]

13154

13155

13749

PARK

13750

STAGE 211

13765 13751 530m²

FUTURE NEW

13764 13752 49167 13762 13763 13752 13762 13764 13764 13754 3906 13764 13765 13755 13754 3906 13755 13

P390ZU D7 13756 450m² W

D/F

13784 PARK

P389ZU

LDJE F FDJELL

LLD/F

13782 | 13783

2720m²

P398ZU

13760

13759

P388ZU

P266ZU

UTURE

NEW SUB

P401ZU

11 3Ø F W W 13751 530m² W P392ZU L D 7 13752 491m²

3356 500kVA@

RODP2 D RP

<u>_new__</u>, 🖫

3Ø (F)

12910

12911

12912

12909\ 12908

12913

12936 12935 12934 12936 12935 12934

643m²

STREET

13748 | FUTURE | 13815 | P424ZU | 13815 | P424ZU | 13816 | P43ZU | 13817 | P43ZU | 13818 | P43ZU | 13818 | P43ZU | 13819 | P43ZU | 13820 | P43ZU | P43

P408ZU 13826

13737 592m² D/F

MS MM

-U NFW

13785 13786 595m² 13786

WS

P409ZU

13735 NEW

NE W P416ZU P7FLL

13787

13123

13128 13127

(13152)

13122

13129

13150

\13149

√13121[°]

13120

13131

13148

13766

13767

13768

13770

13771

13772

13773

13774

| |13777 | 13776 | |13775

FUTURE

STAGE 212

13778 | 13779 | 13780 | 13781

13769

13119

13132

(13147)

13133

13146

13716

13715

13713

13711

13710

13708

SITE PLAN (1:1000 AT A1)

13709

13714

13712

13145

13101 13100

13102

13114 13115

\13116[\]

STAGES

13135 13134

13144

13103

13104

13113

13136

、13137[\]

13142 13143

13717

13719

13720

13721

13722

13723

13724

13725

13729 | 13730 | 13731 | 13732 | 13733

LEADWORT

13718

, 13138

13141

13726

13728

13105

13112

13106

13111

13139

13591

13592

13107 13108 13109

13593



DES A.GANGUR	POWER	SERVICES - PALMERSTON DISTRIBUTION
DRN K.TAVENER	Subdivi	ISION OF LOT 12087
CKD A.GANGUR	ZUCCOL	LI SUBDIVISION - STAGE 2 : STAGE 211
APPD	MASTER	r services plan
SCALE 1:1000 AT A	1	
ISSUED 9-10-20	- A1	DRAWING B20-15006
ALL DIM. IN mm	7 /4	NUMBER DZU-13006 /0\

DRAFTING STANDARD TO A.S.1100 FILE No: NE590/12087

TAMDT

NOTES - WORKS BY DEVELOPERS CONTRACTOR

- 1 ALL WORKS SHALL BE CARRIED OUT IN ACCORDANCE WITH CURRENT POWER AND WATER CONSTRUCTION METHODS, REQUIREMENTS & STANDARDS AS DETAILED IN POWER AND WATER DESIGN AND CONSTRUCTION GUIDELINES, UNDERGROUND MANUAL & ACCESS TO APPARATUS RULES.
- 2 ALL PURCHASED MATERIALS/EQUIPMENT TO CONSTRUCT ELECTRICAL RETICULATION SHALL BE IN ACCORDANCE WITH POWER AND WATER'S RELEVANT STANDARDS/TECHNICAL REQUIREMENTS AND FROM A POWER AND WATER AUTHORISED MANUFACTURER, SPECIFICALLY FOR HIGH VOLTAGE AND LOW VOLTAGE DISTRIBUTION NETWORKS. ANY NON-STANDARD MATERIALS/EQUIPMENT USED WITHOUT OBTAINING PRIOR APPROVAL IN WRITING FROM POWER NETWORKS, ASSET MANAGEMENT QUALITY GROUP CAN BE REJECTED AND REPLACED BY THE APPROVED STANDARD ITEM BEFORE POWER AND WATER ACCEPTS THE HANDOVER OF ELECTRICAL ASSETS AND ISSUING POWER CLEARANCE FOR THE CONSTRUCTION/DEVELOPMENT. IF UNSURE, CONTACT POWER AND WATER POWER NETWORK ASSET MANAGEMENT QUALITY GROUP ON standardsengineers@powerwater.com.au.
- 3 IN COMPLIANCE TO SAFETY REQUIREMENTS REGARDING ACCESS TO APPARATUS RULES, ALL OPENINGS OR TRENCHES IN FRONT OF APPLICABLE POWER ASSETS WHICH ARE CURRENTLY IN SERVICE MUST BE BACKFILLED OR HAVE SUBSTANTIAL COVER (SUITABLE STEEL PLATE OR 19mm FORM PLY SECURED TO A 150mm x 100mm TIMBER CROSS MEMBERS) OVER THE OPENINGS WHEN WORKS HAVE COMPLETED FOR THE DAY IN ORDER TO ALLOW POWER AND WATER'S PERSONNEL SAFE ACCESS TO THE APPARATUS & TO PERFORM ANY SWITCHING IF REQUIRED, IN ADDITION TO CURRENT STANDARD FENCING ARRANGEMENT.
- 4 CONTRACTOR SHALL CONTACT & SUBMIT AN UNDERGROUND INSTALLATION PROGRAM" TO POWER AND WATER'S PROGRAM DELIVERY VIA E-MAIL (programdelivery.pwc@powerwater.com.au) THIRTY (30) DAYS PRIOR TO COMMENCEMENT OF CONSTRUCTION WORKS. THE UNDERGROUND INSTALLATION IS SUBJECT TO APPROVAL BY PROGRAM DELIVERY 7 DAYS PRIOR TO WORK COMMENCING.
- 5 SUBSTATION SHALL BE SUPPLIED BY CONTRACTOR AND SHALL BE MK3 (11kV/433V) TYPE IN ACCORDANCE WITH POWER AND WATER STANDARD DWG'S S02-01-07-18_1, S02-01-07-18_2, S02-01-07-18_3 & S02-01-07-18_4. SUBSTATION SHALL BE INSTALLED BY CONTRACTOR IN ACCORDANCE WITH POWER AND WATER STANDARD DWG'S S02-02-05-10, S02-02-06-33, S02-02-06-37_1, S02-02-06-37_2, S02-02-06-37_3, S02-02-06-37_4, S02-02-06-40 & S02-02-06-41. "ARMCO" SAFETY BARRIERS ARE NOT REQUIRED. CONTRACTOR SHALL DELIVER/PICK UP TO/FROM POWER AND WATER BEN HAMMOND WORKSHOP AND ARRANGE FOR POWER AND WATER TO TEST NEW SUBSTATION/HV SWITCHGEAR & SUPPLY/INSTALL NEW SIM CARD FOR TARIFF METER FOR NEW SUBSTATION. CONTACT IS KATHY WILMOT, TELEPHONE No. 8985 7186. SUBSTATION SHALL BE POWDER COATED TO AS 3715 COLOR "HERITAGE GREEN"
- 6 FUSED DISTRIBUTION PILLARS SHALL BE SUPPLIED AND INSTALLED BY CONTRACTOR AND LABELLED IN ACCORDANCE WITH POWER AND WATER REQUIREMENTS. LABELS SHALL BE PROVIDED BY CONTRACTOR. PILLARS SHALL BE TYPE IN ACCORDANCE WITH POWER AND WATER STANDARD DWG S02-02-03-08 & INSTALLATION IN ACCORDANCE WITH POWER AND WATER STD DWG'S S02-02-03-12 & S02-02-03-13.
- 7 SERVICE ALLOCATIONS SHALL BE AS PER DWG No. B20-15003, DETAIL A AND SHALL BE INSTALLED IN ACCORDANCE WITH POWER AND WATER STANDARD DWG'S S02-02-06-02 AND S02-02-06-03 (TRENCH DETAILS). ALSO REFER DWG No. B20-15003, DETAILS B & C.

13421

J12515

<u>1244</u>5

12459

12460

¹²⁴⁴⁴ RM6 (ZUCCOLI

PARADE RMU-2)

13423

SUB 3358

RM6 (ZUCCOLI Hz

PARADE RMU-1)

13418

.12516

_ **→** TO SUB 3302

HV SW13028

12517

DRS

人13420

13417

_____13348

DRS

12447

12446

RM6 (7UCCOLL

PARADE RMU-3)

13349

13350

TO SUB 3325

HV SW13240

->TO SUB 3476

HV SW21276

12449

12448

13351

SUB 3352

13419

SUB 3357

->TO SUB 3188

HV SW12718

-

SUB

3187

SPARE 13424

J 12440

12438

12447

12458

TO SUB 3331

HV SW13257

12439占

TO RMU V

RM6NE-III

SW12093

(LAMBRICK AVE)

124419


- 8 ELECTRICITY EASEMENTS SHALL BE IN ACCORDANCE WITH POWER AND WATER STANDARD DWG'S S02-02-06-17.
- SUBSTATIONS : 4mx3.5m,
- FUSED PILLARS: 1mx1m WHERE PILLAR FULLY IN 1 LOT OR 0.5mx1m WHERE HALF PILLAR IN 2 LOTS (IE ON COMMON BOUNDARY) FOR 3 \$ 5 SLOT FUSED PILLAR.

WHERE FRONT/SIDE OF SUBSTATION/PILLARS ELECTRICTY EASEMENTS DO NOT ALIGN WITH FRONT OF SIDE LOT BOUNDARIES, ELECTRICITY EASEMENTS SHALL EXTEND TO FRONT OR SIDE LOT BOUNDARY. DEVELOPER SHALL SURVEY & REGISTER ELECTRICITY EASEMENTS REQUIRED IN FAVOUR OF POWER AND WATER (AT NO COST TO POWER AND WATER).

- 9 LV CABLES SUPPLIED AND INSTALLED BY CONTRACTOR SHALL BE TYPE IN ACCORDANCE WITH POWER AND WATER STANDARD DWG'S S02-01-01-19 AND S02-01-01-20. HV CABLES SUPPLIED & INSTALLED BY CONTRACTOR SHALL BE TYPE IN ACCORDANCE WITH POWER AND WATER STANDARD DWG S02-01-01-25.
- 10 SERVICE CABLES FROM DIST. PILLARS TO WITHIN EACH LOT IS TO BE PROVIDED BY LOT OWNER.
- 11 CONTRACTOR SHALL LIAISE WITH NBN CONTRACTOR TO ENABLE CONDUITS AND COMMUNICATIONS PITS TO BE INSTALLED BY NBN CONTRACTOR AT THE APPROPRIATE CONSTRUCTION STAGE (INCLUDING CONDUITS AT ROAD CROSSINGS). THE CONTRACTOR SHALL BACKFILL/COMPACT TRENCHES, UPON INSTALLATION OF ELECTRICAL SERVICES CABLING, TO A LEVEL IN ACCORDANCE WITH STANDARD POWER AND WATER DWG S02-02-06-02 TO ENABLE NBN CONTRACTOR TO INSTALL COMMUNICATIONS CONDUITS AND PITS. THE CONTRACTOR SHALL THEN COMPLETE BACKFILL/COMPACTION OF TRENCHES.
- 12 CONTRACTOR SHALL INSTALL ALL NUMBER PLATES (LABELS) REQUIRED BY POWER AND WATER IE SUBSTATIONS & PILLARS, NOTE - SUBSTATION NUMBER PLATES & HV SWITCHES NUMBER PLATES WILL BE PROVIDED BY POWER AND WATER TO CONTRACTOR. CONTRACTOR SHALL LABEL ALL CABLE DESTINATIONS IN ACCORDANCE WITH POWER AND WATER STANDARD DRAWING S02-01-08-25.
- 13 ALL WORKS REQUIRED ON EXISTING ENERGISED RETICULATION SHALL ONLY BE CARRIED OUT BY POWER AND WATER PERSONNEL. DEVELOPER/CONTRACTOR SHALL LIAISE WITH POWER AND WATER TO COORDINATE CONNECTION OF THE WORK INTO EXISTING UNDERGROUND RETICULATION. ALL COSTS ASSOCIATED SHALL BE PAID BY DEVELOPER.
- 14 DEVELOPER SHALL ENSURE THAT ONLY POWER AND WATER ACREDITED ELECTRICAL CONTRACTOR IS EMPLOYED TO CARRY OUT WORK ON THIS ELECTRICAL SYSTEM (CONTACT MANAGER NETWORK FNGINFERING 8924 5191).
- 15 DEVELOPER SHALL LIAISE WITH POWER AND WATER TO OBTAIN "HANDOVER OF WORK BY DEVELOPER". CONTRACTOR SHALL SUBMIT TO POWER AND WATER ON COMPLETION OF WORK, SIGNED COPY OF "CONTRACTOR'S CERTIFICATE OF COMPLETION & HANDOVER POWER NETWORK ASSETS" & SIGNED COPY OF "ELECTRICAL CERTIFICATE OF COMPLIANCE".
- 16 CABLE ROUTE LENGTHS NOMINATED ON SINGLE LINE DIAGRAM ARE FOR POWER AND WATER INFORMATION ONLY & SHALL NOT BE USED FOR TENDERING PURPOSES.
- 17 COORDINATE WITH CIVIL SERVICES FOR LOCATION OF WATER, SEWERAGE AND DRAINAGE SERVICES.

18 - CONTRACTOR SHALL PROVIDE "AS CONSTRUCTED" DRAWINGS IN ACCORDANCE WITH POWER AND WATER'S "POWER NETWORKS DESIGN AND CONSTRUCTION GUIDELINES", INCLUDING A COPY OF THE FINAL SURVEY PLAN. THE "AS CONSTRUCTED" DRAWINGS SHALL INCLUDE:

- 1 x A1 PAPER PRINT INDICATING "AS INSTALLED" (OF ALL DRAWINGS).
- 1 x A3 PAPER PRINT INDICATING "AS INSTALLED" (OF ALL DRAWINGS). - 1 DIGITAL (CD OR USB) COPY OF ALL DRAWINGS (MICROSTATION DGN FILES).

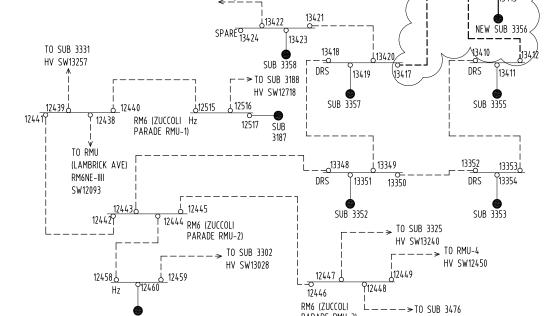

NOTES - WORKS BY POWER AND WATER (AT DEVELOPERS COST)

- GIFTED ASSETS
- 1 CONTRACTOR SHALL ARRANGE FOR POWER AND WATER TO CARRY OUT THE FOLLOWING WORKS:
- PULL THROUGH NEW HV CABLING (FROM NEW SUB 3356, HV SW13413) LEFT COILED IN EXISTING SAND PIT IN FRONT OF EXISTING SUB 3355 & CONNECT/TERMINATE TO EXISTING SUB 3355, HV SW13412.
- PULL THROUGH NEW HV CABLING (FROM NEW SUB 3356, HV SW13414) LEFT COILED IN EXISTING SAND PIT IN FRONT OF EXISTING SUB 3357 & CONNECT/TERMINATE TO EXISTING SUB 3357. HV SW13417.
- PULL THROUGH NEW LV DIST. CABLING (FROM NEW DIST. PILLAR P416ZU) LEFT COILED IN EXISTING SAND PIT IN FRONT OF EXISTING DIST. PILLAR P080ZU & CONNECT/TERMINATE TO EXISTING DIST. PILLAR P080ZU.
- CARRY OUT FARTH TESTS.
- SUPPLY & INSTALL TARRIF METER FOR NEW SUBSTATION. SUPPLY NUMBER PLATES (LABELS) FOR CONTRACTOR TO INSTALL.
- COMPLETE FINAL CONNECTION, TESTING & COMMISSIONING OF NEW SUBSTATION, DISTRIBUTION PILLARS & ASSOCIATED CABLING/WORKS.
- 2 DEVELOPER SHALL PAY ALL ASSOCIATED COSTS FOR POWER AND WATER TO CARRY OUT ABOVE WORKS. POWER AND WATER'S FINAL CONNECTION QUOTE FOR PAYMENT SHALL ONLY BE PROVIDED TO THE DEVELOPER OR THE DEVELOPER'S SUCCESSFUL ELECTRICAL CONTRACTOR WITH A WRITTEN ADVICE BY THE DEVELOPER.

HV ASSET SCHEDULE										
DESCRIPTION	LOCATION	STOCK CODE	SERIAL NUMBER	TEST NUMBER						
SUB 3356 MK3 500kVA 3-WAY	COMET STREET/ TUCKEROO BLVD/ LASIANDRA AVE/ MYRTLEWOOD CRES ZUCCOLI	503369	TO BE PROVIDED ON "AS CONS"	TO BE PROVIDED ON "AS CONS"						
11kV 1C 240 Sq mm AL/XLPE CABLE	COMET STREET/ TUCKEROO BLVD/ LASIANDRA AVE/ MYRTLEWOOD CRES ZUCCOLI	286021	N/A	N/A						

LV ASSET SCHEDULE										
DESCRIPTION LOCATION STOCK CODE SERIAL NUMBER TEST NUMBE										
LV PILLAR P391ZU/P392ZU, P401ZU TO P406ZU '3' SLOT	LASIANDRA AVE ZUCCOLI	292326	N/A	N/A						
LV PILLAR P390ZU/P407ZU '5' SLOT	LASIANDRA AVE ZUCCOLI	292334	N/A	N/A						
LV PILLAR P416ZU '5' SLOT	CORKWOOD STREET ZUCCOLI	292334	N/A	N/A						
LV PILLAR P408ZU/P410ZU '3' SLOT	LEADWORT CRT ZUCCOLI	292326	N/A	N/A						
240 Sq mm AL/XLPE CABLE	LASIANDRA AVE/ LEADWORT CRT/ CORKWOOD STREET ZUCCOLI	401015	N/A	N/A						
25 Sq mm Cu/XLPE CABLE	LASIANDRA AVE ZUCCOLI	9449/9456	N/A	N/A						

		3153 V SCHEMATIC DIAGR	AM (11AR07 MITCH	IELL	CREEK) (N T S)						SUB 3153 NEW HV SCHEMATI	ור ו	PARADE RMU-3) DIAGRAM (11AR07 MITCHELL CI			SW21276
	DEVELOPER:				(n.1.3.)						NEW IIV SCHEINTI		DRAWING STATUS	APPD		
	PERRITORY LIFE	AGA CONSU									F	Р	PRELIMINARY/PROPOSED	ALLO	DATE	
	PO Box 1779 PARWIN NT 0801	ELECTRICAL A(N 070 242 296	L & MECHANICAL								T A	-+	TENDERING PURPOSES ONLY APP. FOR CONSTRUCTION			
									B20-15008 B20-15006 B20-15005 B20-15004 B20-15003	SINGLE LINE DIAGRAM & LEGEND MASTER SERVICES PLAN CONDUIT/DUCT LAYOUT LEVETICAL RETICULATION HV ELECTRICAL RETICULATION	A	J	AS INSTALLED			
- 1 '	PHONE: 0417 160700	GPO BOX 3097	TELEPHONE: 08 89416582	0	CONTRACT DRAWING	K.T.	9-10-20	A.G.	B20-15004 B20-15003	LV ELECTRICAL RETICULATION HV ELECTRICAL RETICULATION	(CANCELLED/SUPERSEDED			
	ACSIMILE: [MAIL: clement.williams@territorylife.com.au	DARWIN NT 0801	FACSIMILE: 08 89421400	NO	DESCRIPTION	DRN	DATE	APPD	DRG NO	TITLE						
	CONTACT: CLEMENT WILLIAMS		EMAIL: alekg@agaeng.com.au		AMENDMENTS					ASSOCIATED DRAWINGS			AGA406-20A			

137, 10

SUB 3355

SUB 3353

13411

13353j

13354

DRS

13352

DRS

-> TO RMU-4

HV SW12450



13414**,**

13415

NEW WORKS

DES	S A.0	GANGUR	POWER	SERVICES -	PALMERSTON	DISTRIBUTIO	N
DRI	N K.	TAVENER	SUBDIV	ISION OF LOT	12087		
CK).A. (GANGUR	ZUCCO	LI SUBDIVISION	- STAGE 2	: STAGE 211	
APF	PD		NOTES,	ASSET SCHED	ULES & HV :	SCHEMATICS	
SCA	ALE N.	Γ.S.					
ISS	UED 9-	10-20	A1	DRAWING NUMBER	D20 15	5007	
ALL	_ DIM. I	N mm	A	NUMBER	DZU-I)007	0\
DRAFTING STANDARD TO A.S.1100				FILE No: NE590	/12087		AMDT

